

# ZEME, LLC STORAGE ADDITION 44 DARLINGTON AVENUE WILMINGTON, NC


MAY, 2016

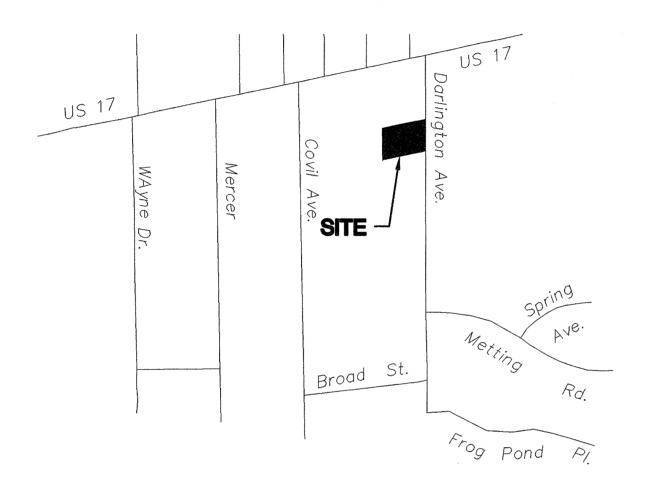

VICINITY MAP NOT TO SCALE

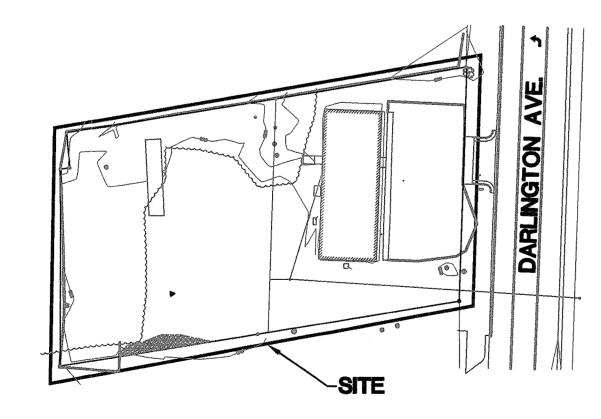

EXISTING SITE MAP NOT TO SCALE

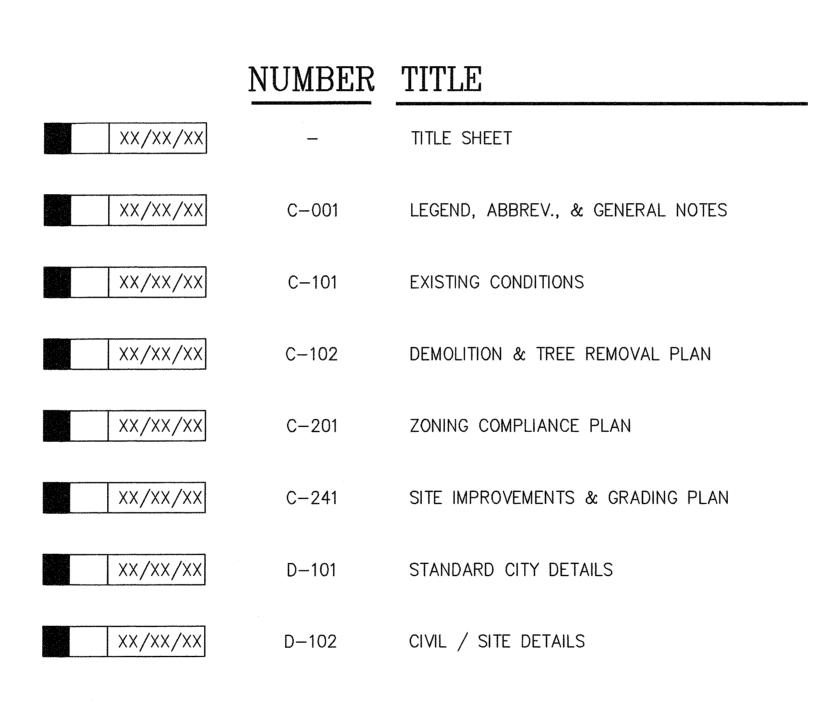

CUT OF CITY STREETS, A \$325 PERMIT SHALL BE REQUIRED FROM THE OCCUPANCY AND/ OR PROJECT ACCEPTANCE.

APPROVED DRAINAGE PLAN

PRELIMINARY PLAN ISSUED FOR AGENCY REVIEW



SITE— DATA TABULATION PARCEL ID#: 04917-004-016-000 ZONING: CS / O&I-1 (SPLIT ZONING/ NO ADJOINING RESIDENTIAL USES) CAMA LAND CLASSIFICATION: URBAN THE PROPERTY DOES NOT LIE WITHIN A SPECIAL FLOOD HAZARD AREA PER FIRM# 3720313700J; MAP EFFECTIVE DATE: APRIL 3, 2006. PARKING & DRIVES: 3,218 SF WALK & PADS: PROPOSED IMPERVIOUS AREA: 3,000 SF PARKING & DRIVE: 1,120 SF WALKS AND PADS: 425 SF 10,417 SF AREA OF SUBJECT PARCEL: 25,264 SF 0.58 AC. (PER SURVEY) PROPOSED PERCENT IMPERVIOUS: 41.2 % EXISTING BUILDING: PROPOSED BUILDING: 3,000 SF 5,338 SF AREA OF SUBJECT PARCEL: 25,264 SF 0.58 AC. (PER SURVEY) PROPOSED BUILDING COVERAGE: 21.1 % PROPOSED USE: STORAGE NUMBER OF PROPOSED BUILDINGS: 1 (1-STORY), +/- 18' HEIGHT PARKING CALCULATIONS: EXISTING FACILITY = 2,354 SF @ 1 PER 400 SF GROSS FLOOR = 6 SPACES NEW WAREHOUSE = 3,000 SF @ 1 PER 1,000 SF GROSS FLOOR = 3 SPACES PARKING REQUIRED: = 9 SPACES PARKING PROVIDED: = 8 SPACES REGULAR -HANDICAPPED -= 1 SPACES


= 9 SPACES


WATER & SEWER BY EXISTING CONNECTIOS/ EXISTING BUILDING ONLY





PROJECT NUMBER

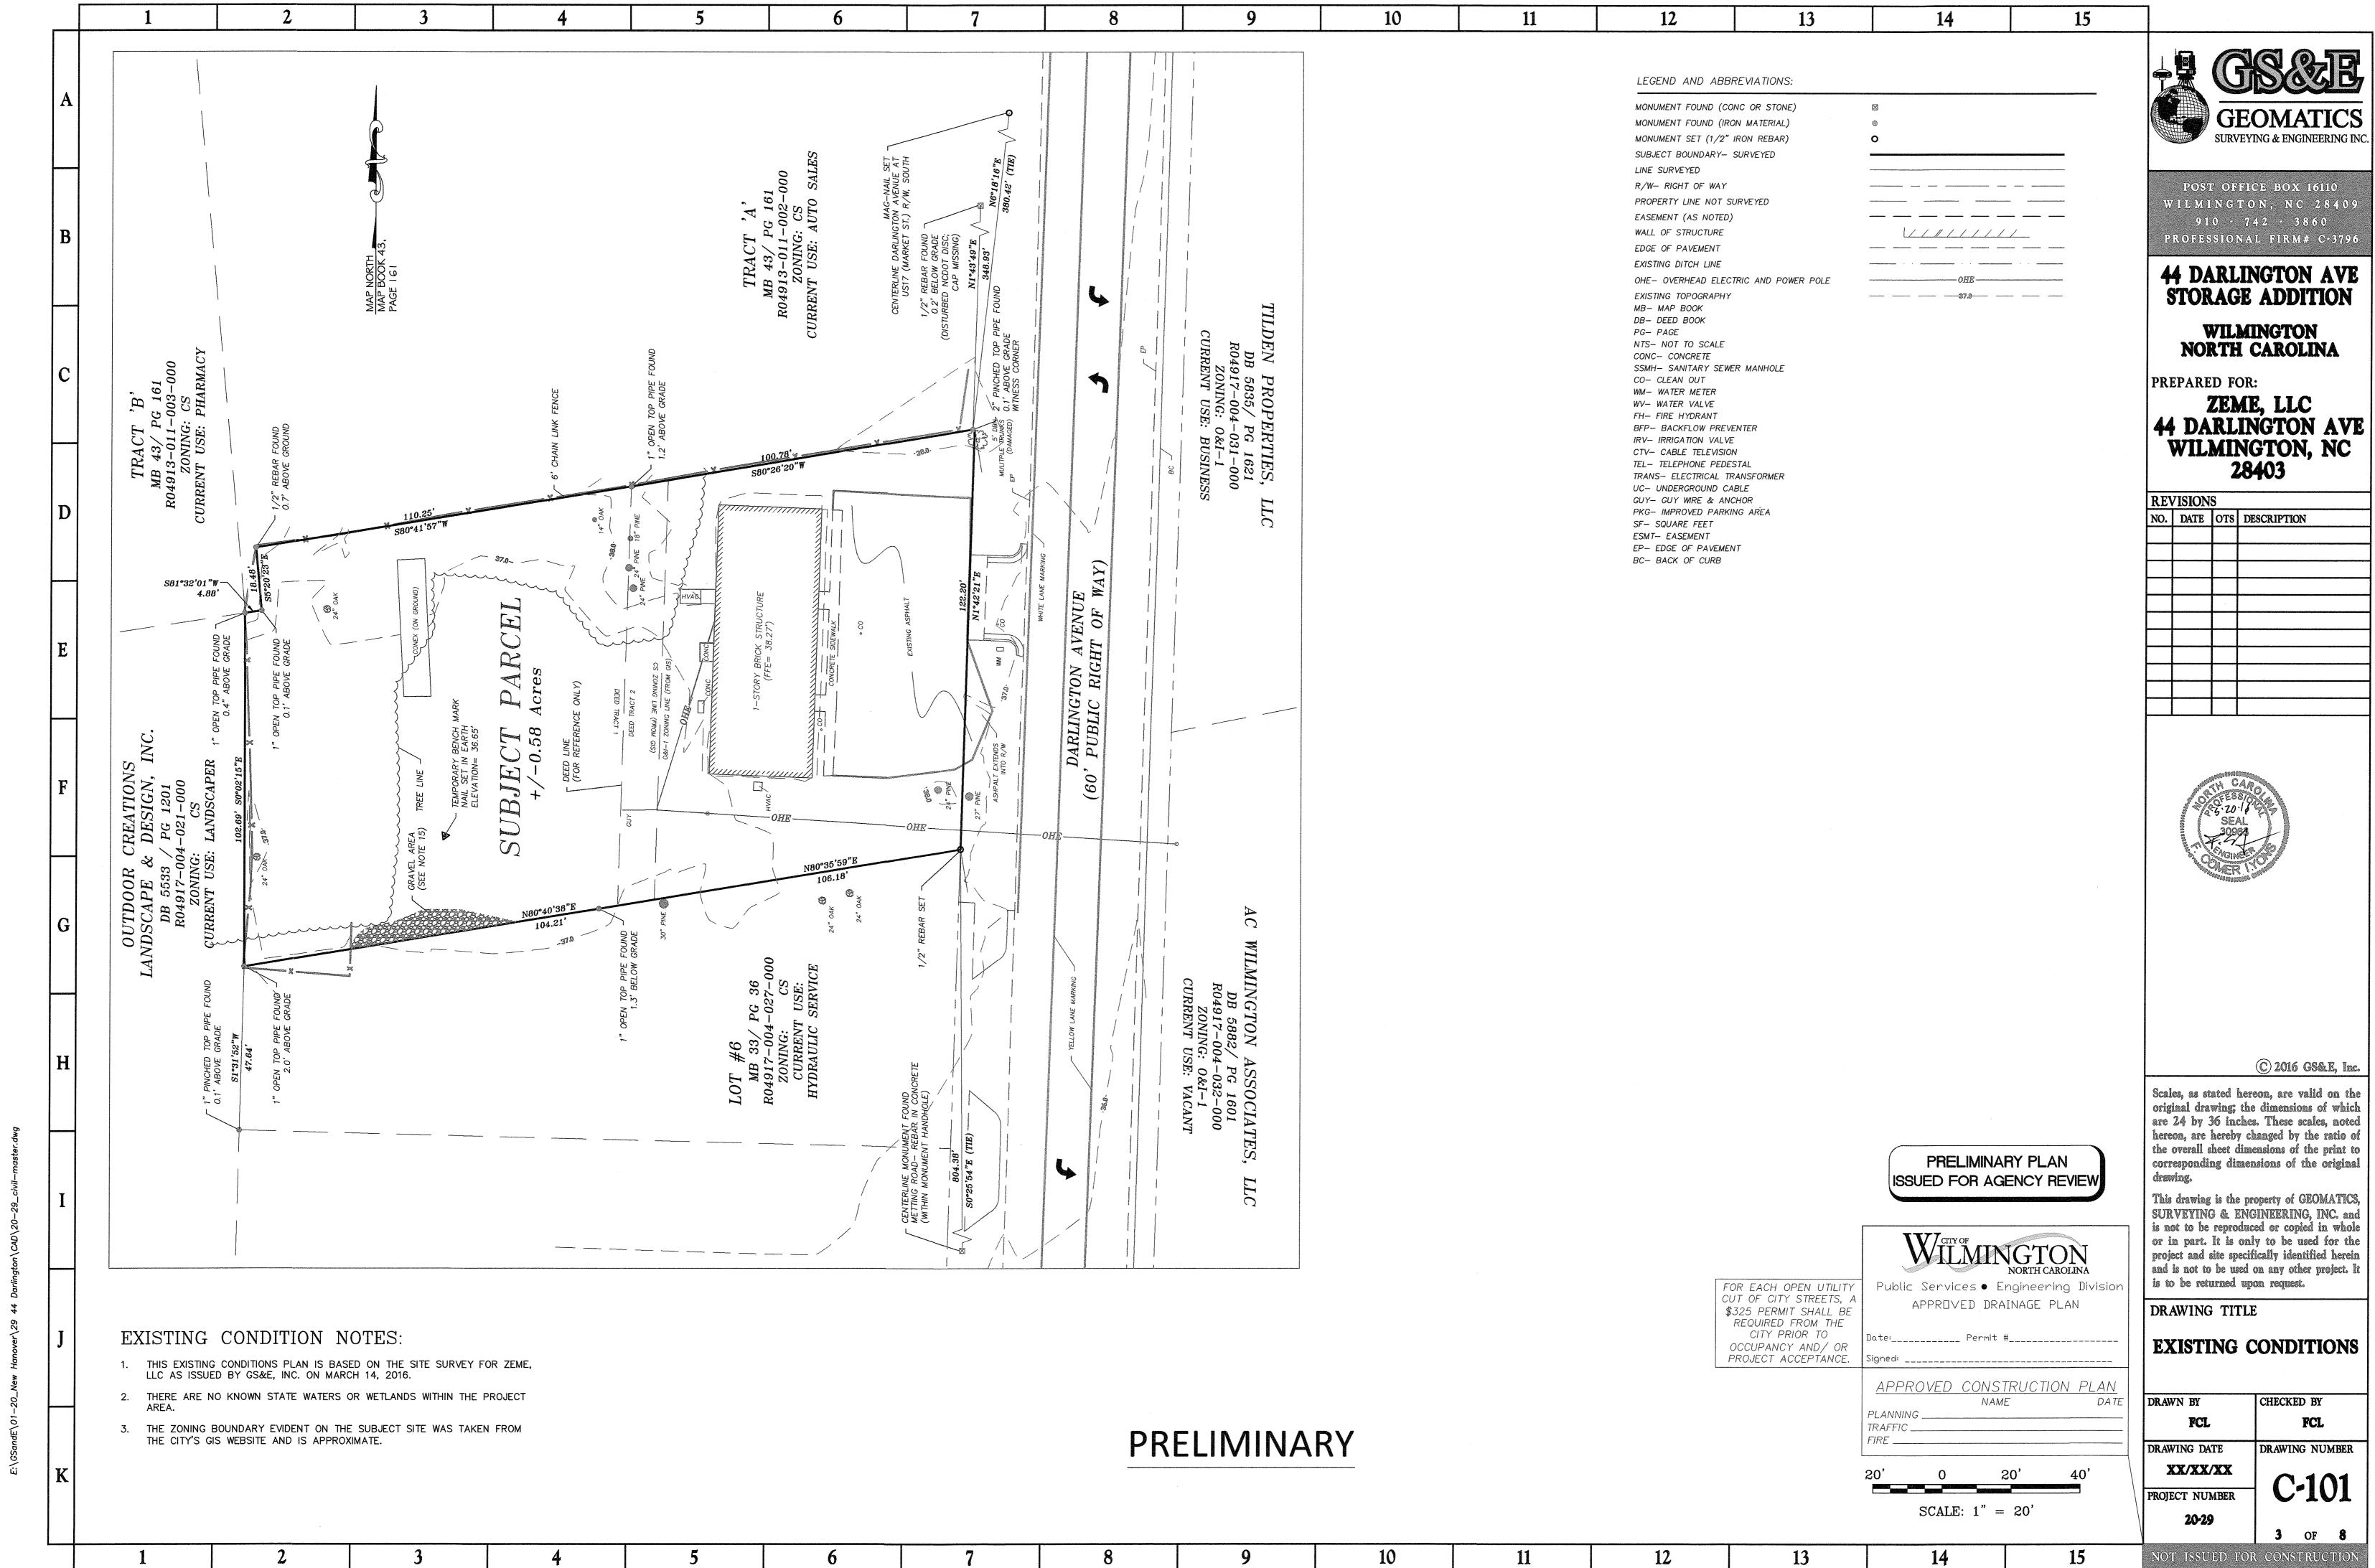

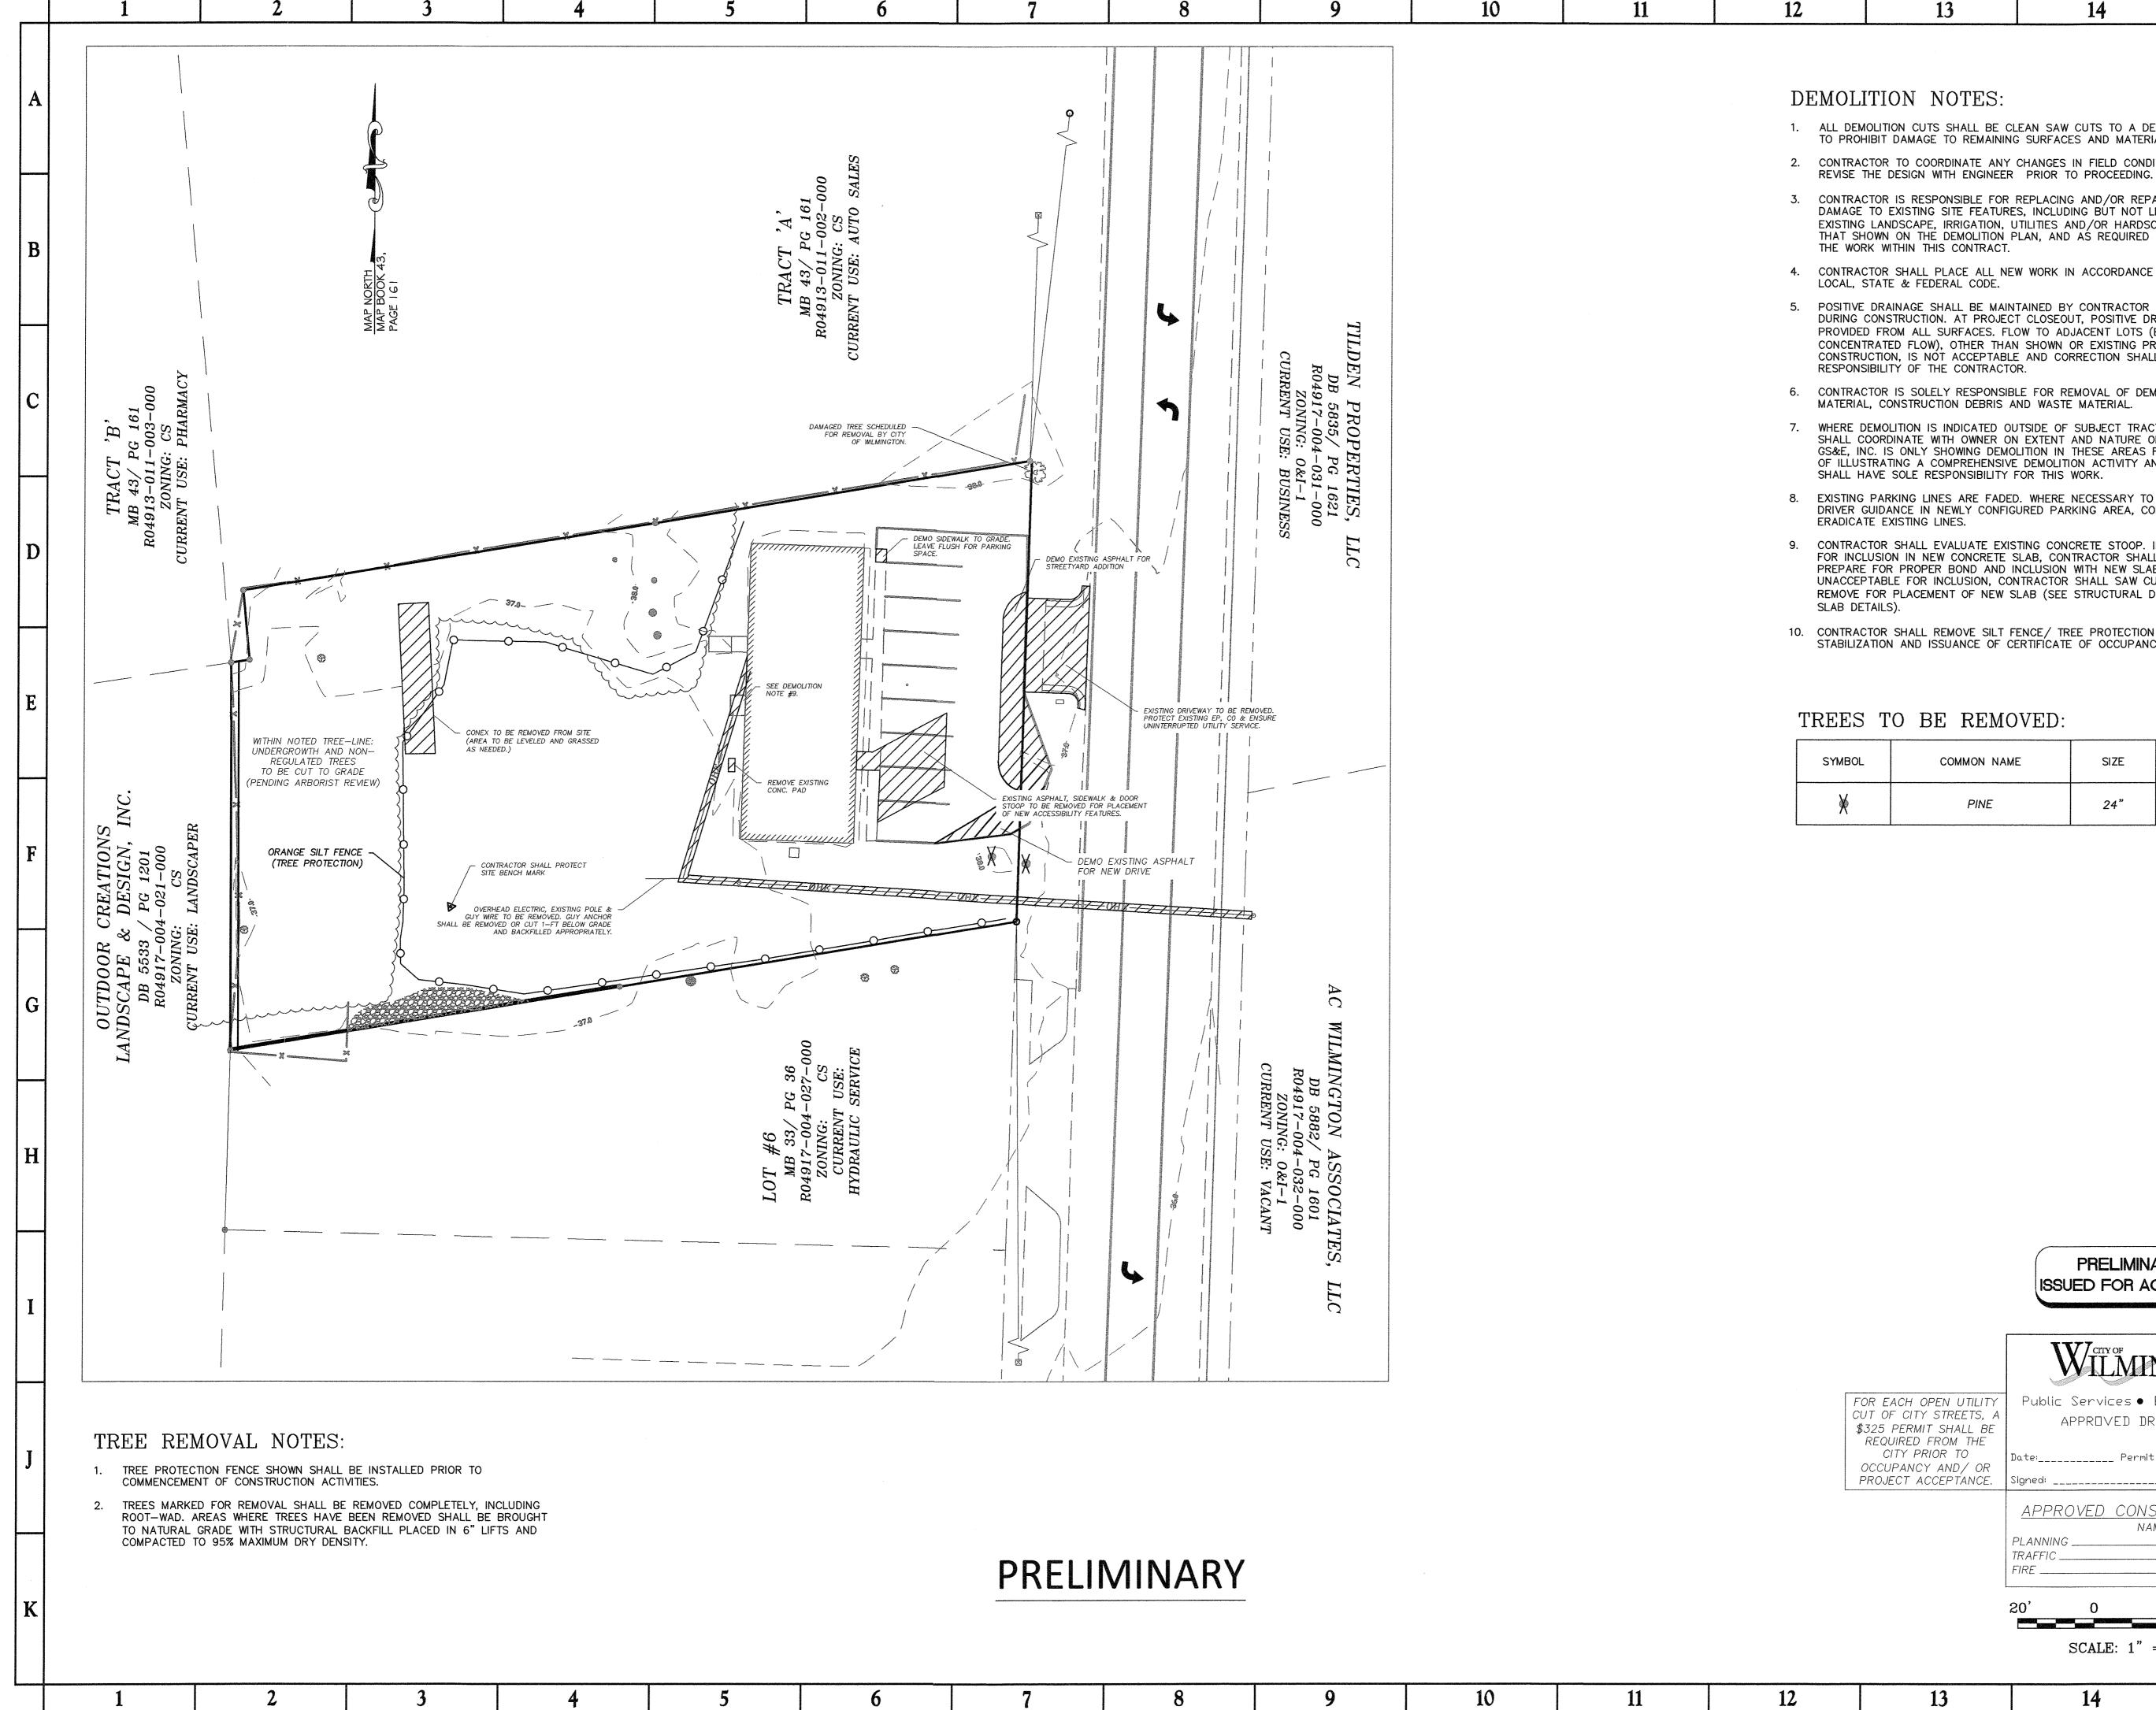

- 1. ALL DEMOLITION CUTS SHALL BE CLEAN SAW CUTS TO A DEPTH SUFFICIENT TO PROHIBIT DAMAGE TO REMAINING SURFACES AND MATERIALS.
- 2. CONTRACTOR TO COORDINATE ANY CHANGES IN FIELD CONDITIONS THAT MAY
- CONTRACTOR IS RESPONSIBLE FOR REPLACING AND/OR REPAIRING ANY DAMAGE TO EXISTING SITE FEATURES, INCLUDING BUT NOT LIMITED TO: EXISTING LANDSCAPE, IRRIGATION, UTILITIES AND/OR HARDSCAPE BEYOND THAT SHOWN ON THE DEMOLITION PLAN, AND AS REQUIRED TO COMPLETE
- CONTRACTOR SHALL PLACE ALL NEW WORK IN ACCORDANCE WITH PLAN AND
- POSITIVE DRAINAGE SHALL BE MAINTAINED BY CONTRACTOR AT ALL TIMES DURING CONSTRUCTION. AT PROJECT CLOSEOUT, POSITIVE DRAINAGE MUST BE PROVIDED FROM ALL SURFACES. FLOW TO ADJACENT LOTS (ESPECIALLY CONCENTRATED FLOW), OTHER THAN SHOWN OR EXISTING PRIOR TO CONSTRUCTION, IS NOT ACCEPTABLE AND CORRECTION SHALL BE THE SOLE
- CONTRACTOR IS SOLELY RESPONSIBLE FOR REMOVAL OF DEMOLISHED MATERIAL, CONSTRUCTION DEBRIS AND WASTE MATERIAL.
- WHERE DEMOLITION IS INDICATED OUTSIDE OF SUBJECT TRACT, CONTRACTOR SHALL COORDINATE WITH OWNER ON EXTENT AND NATURE OF ACTIVITY. GS&E, INC. IS ONLY SHOWING DEMOLITION IN THESE AREAS FOR PURPOSES OF ILLUSTRATING A COMPREHENSIVE DEMOLITION ACTIVITY AND CONTRACTOR SHALL HAVE SOLE RESPONSIBILITY FOR THIS WORK.
- EXISTING PARKING LINES ARE FADED. WHERE NECESSARY TO PROVIDE CLEAR DRIVER GUIDANCE IN NEWLY CONFIGURED PARKING AREA, CONTRACTOR SHALL
- 9. CONTRACTOR SHALL EVALUATE EXISTING CONCRETE STOOP. IF ACCEPTABLE FOR INCLUSION IN NEW CONCRETE SLAB, CONTRACTOR SHALL CLEAN AND PREPARE FOR PROPER BOND AND INCLUSION WITH NEW SLAB. IF DEEMED UNACCEPTABLE FOR INCLUSION, CONTRACTOR SHALL SAW CUT CLEAN AND REMOVE FOR PLACEMENT OF NEW SLAB (SEE STRUCTURAL DRAWINGS FOR
- 10. CONTRACTOR SHALL REMOVE SILT FENCE/ TREE PROTECTION UPON SITE STABILIZATION AND ISSUANCE OF CERTIFICATE OF OCCUPANCY.

SYMBOL	COMMON NAME	SIZE	QUANTITY	
*	PINE	24"	2	

PRELIMINARY PLAN

ISSUED FOR AGENCY REVIEW

Public Services • Engineering Division


APPROVED DRAINAGE PLAN

APPROVED CONSTRUCTION PLAN

SCALE: 1" = 20'

15

15

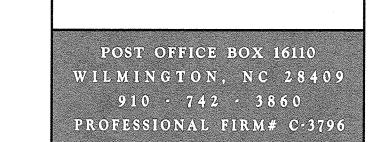

### 44 DARLINGTON AVE STORAGE ADDITION

WILMINGTON NORTH CAROLINA

PREPARED FOR:

# ZEME, LLC 44 DARLINGTON AVE WILMINGTON, NC 28403

REV	REVISIONS		
NO.	DATE	OTS	DESCRIPTION



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Scales, as stated hereon, are valid on the original drawing; the dimensions of which are 24 by 36 inches. These scales, noted hereon, are hereby changed by the ratio of the overall sheet dimensions of the print to corresponding dimensions of the original drawing.

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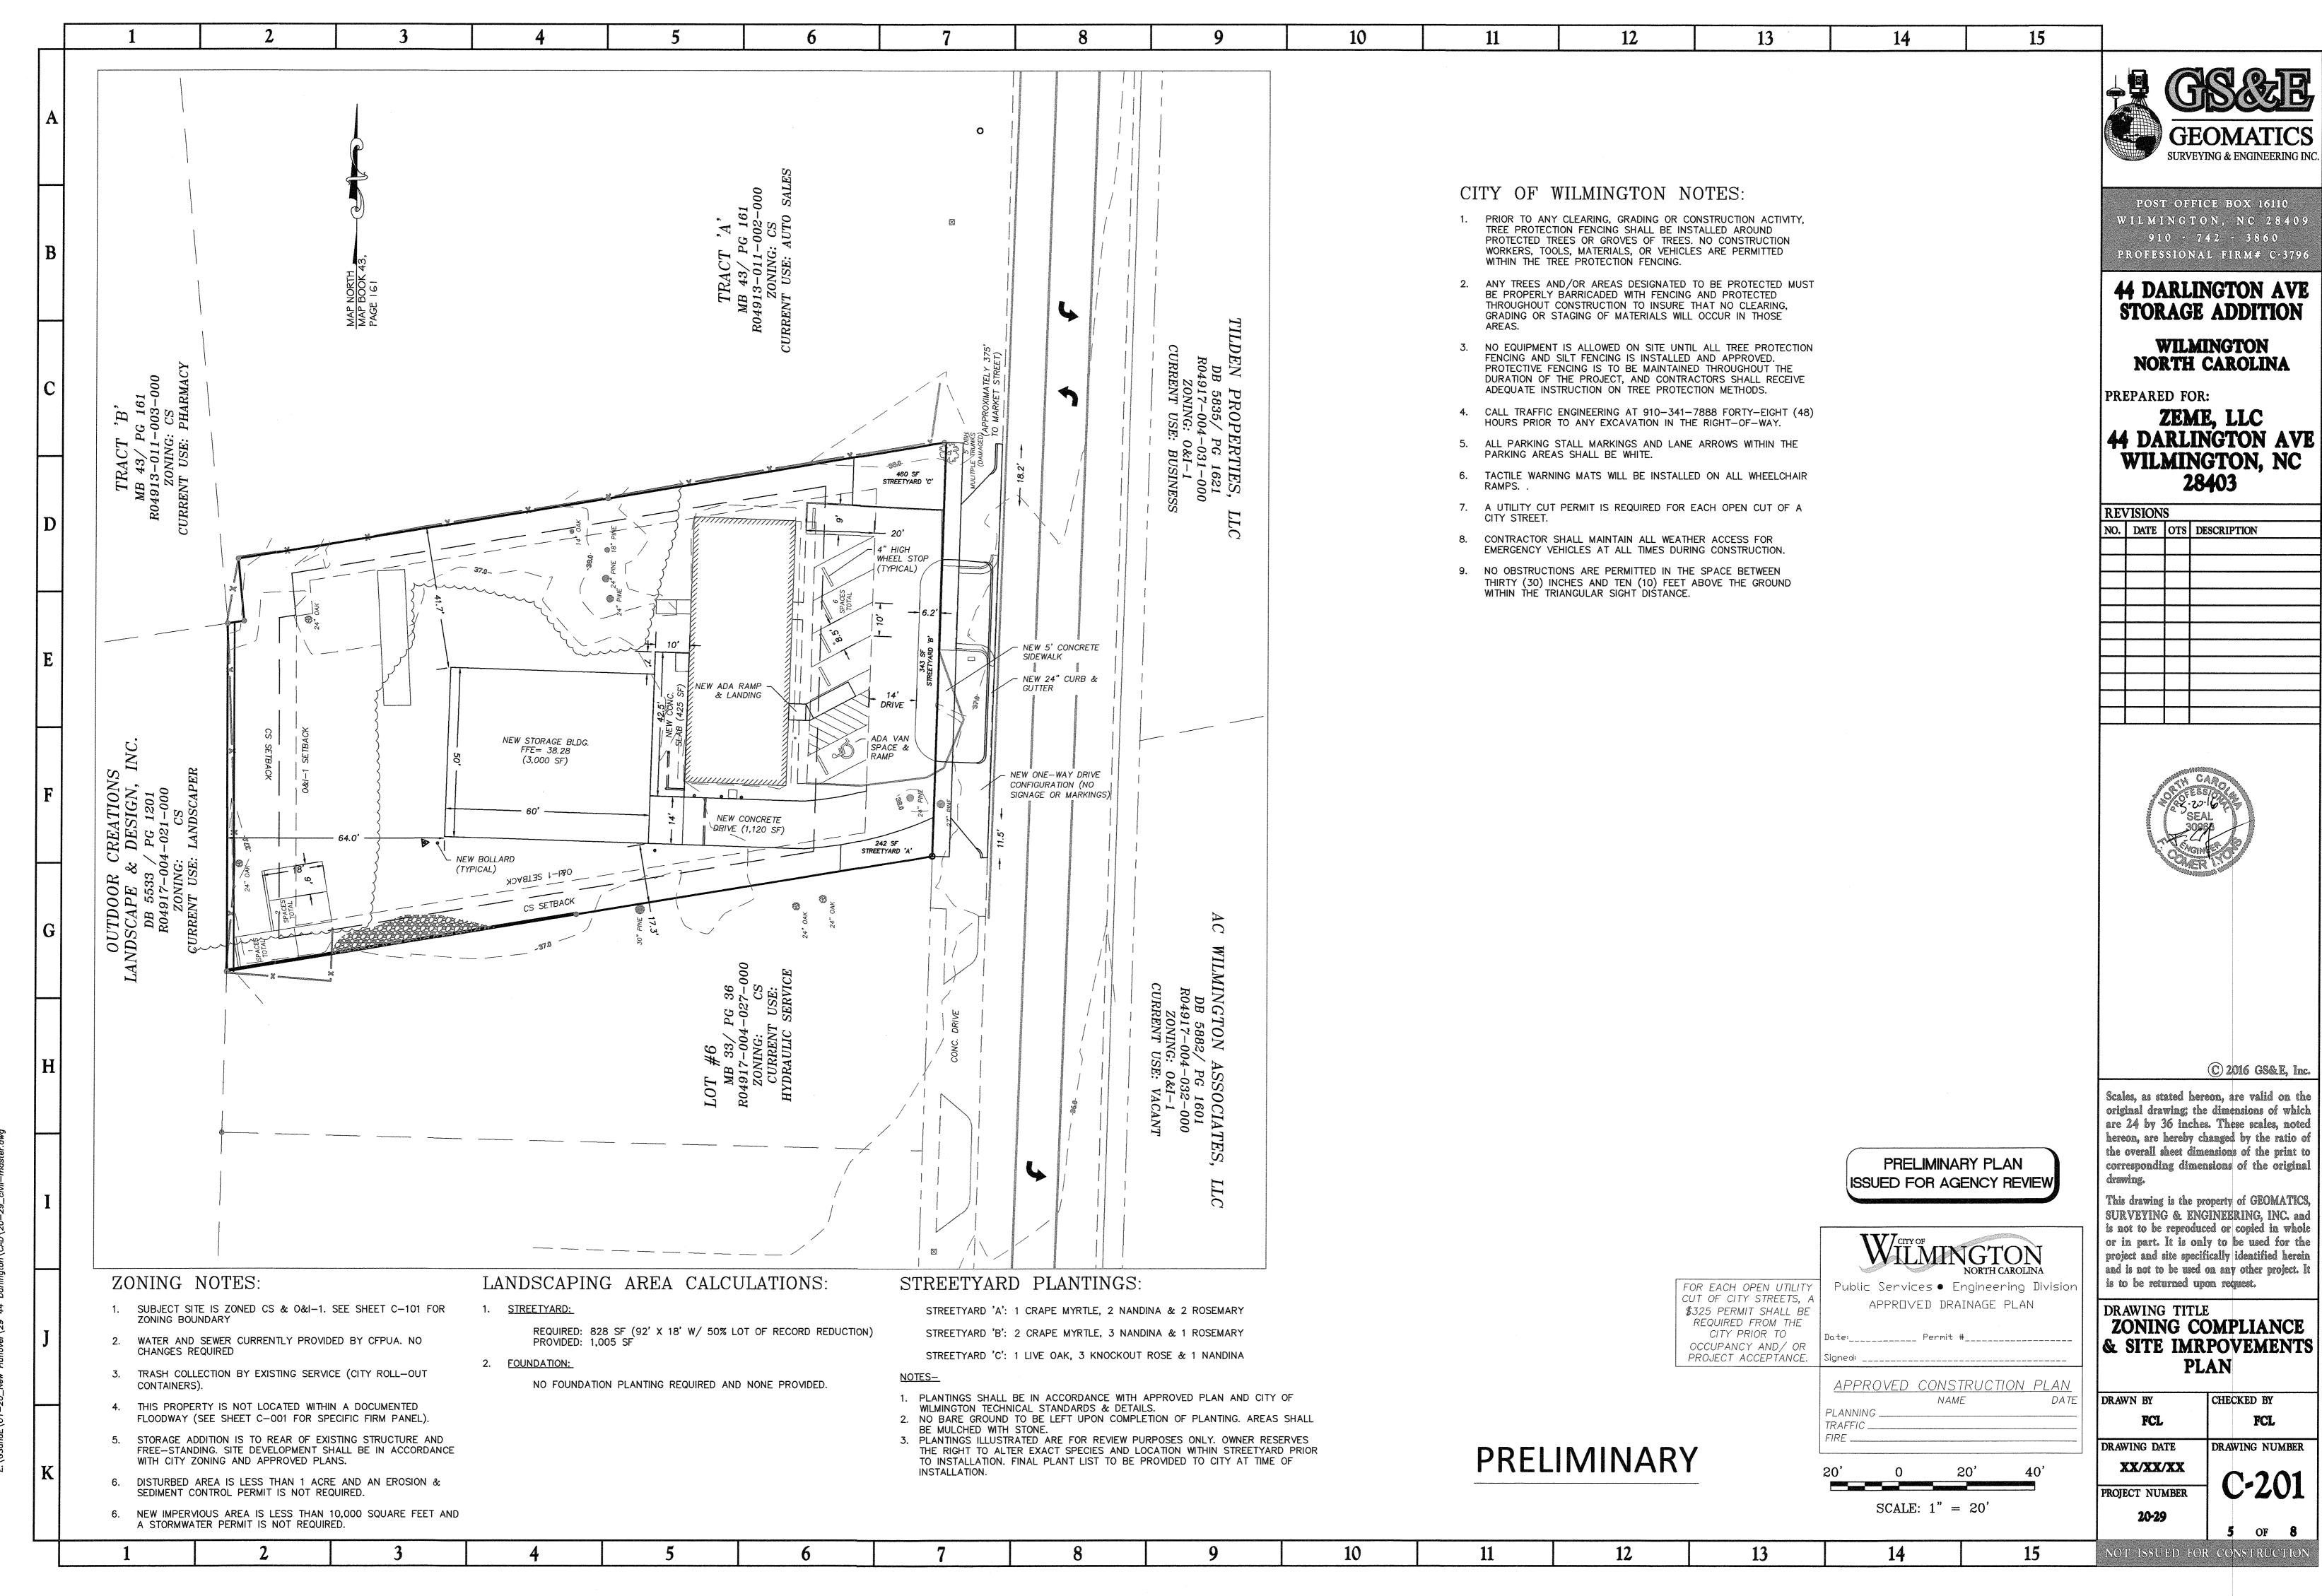
### DRAWING TITLE DEMOLITION & TREE REMOVAL **PLAN**

DRAWN BY	CHECKED BY
FCL	FCL
DRAWING DATE	DRAWING NUMBER
XX/XX/XX	C-102

C107 PROJECT NUMBER 20-29

4 OF 8

OT ISSUED FOR CONSTRUCTION



POST OFFICE BOX 16110 WILMINGTON, NC 28409 PROFESSIONAL FIRM# C-3796

REV	REVISIONS				
NO.	DATE	OTS	DESCRIPTION		


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### ZONING COMPLIANCE & SITE IMRPOVEMENTS

DRAWN BY	CHECKED BY
FCL	FCL
DRAWING DATE	DRAWING NUMBER
XX/XX/XX	0 201
PROJECT NUMBER	C-201
20.20	



#### GRADING NOTES:

10

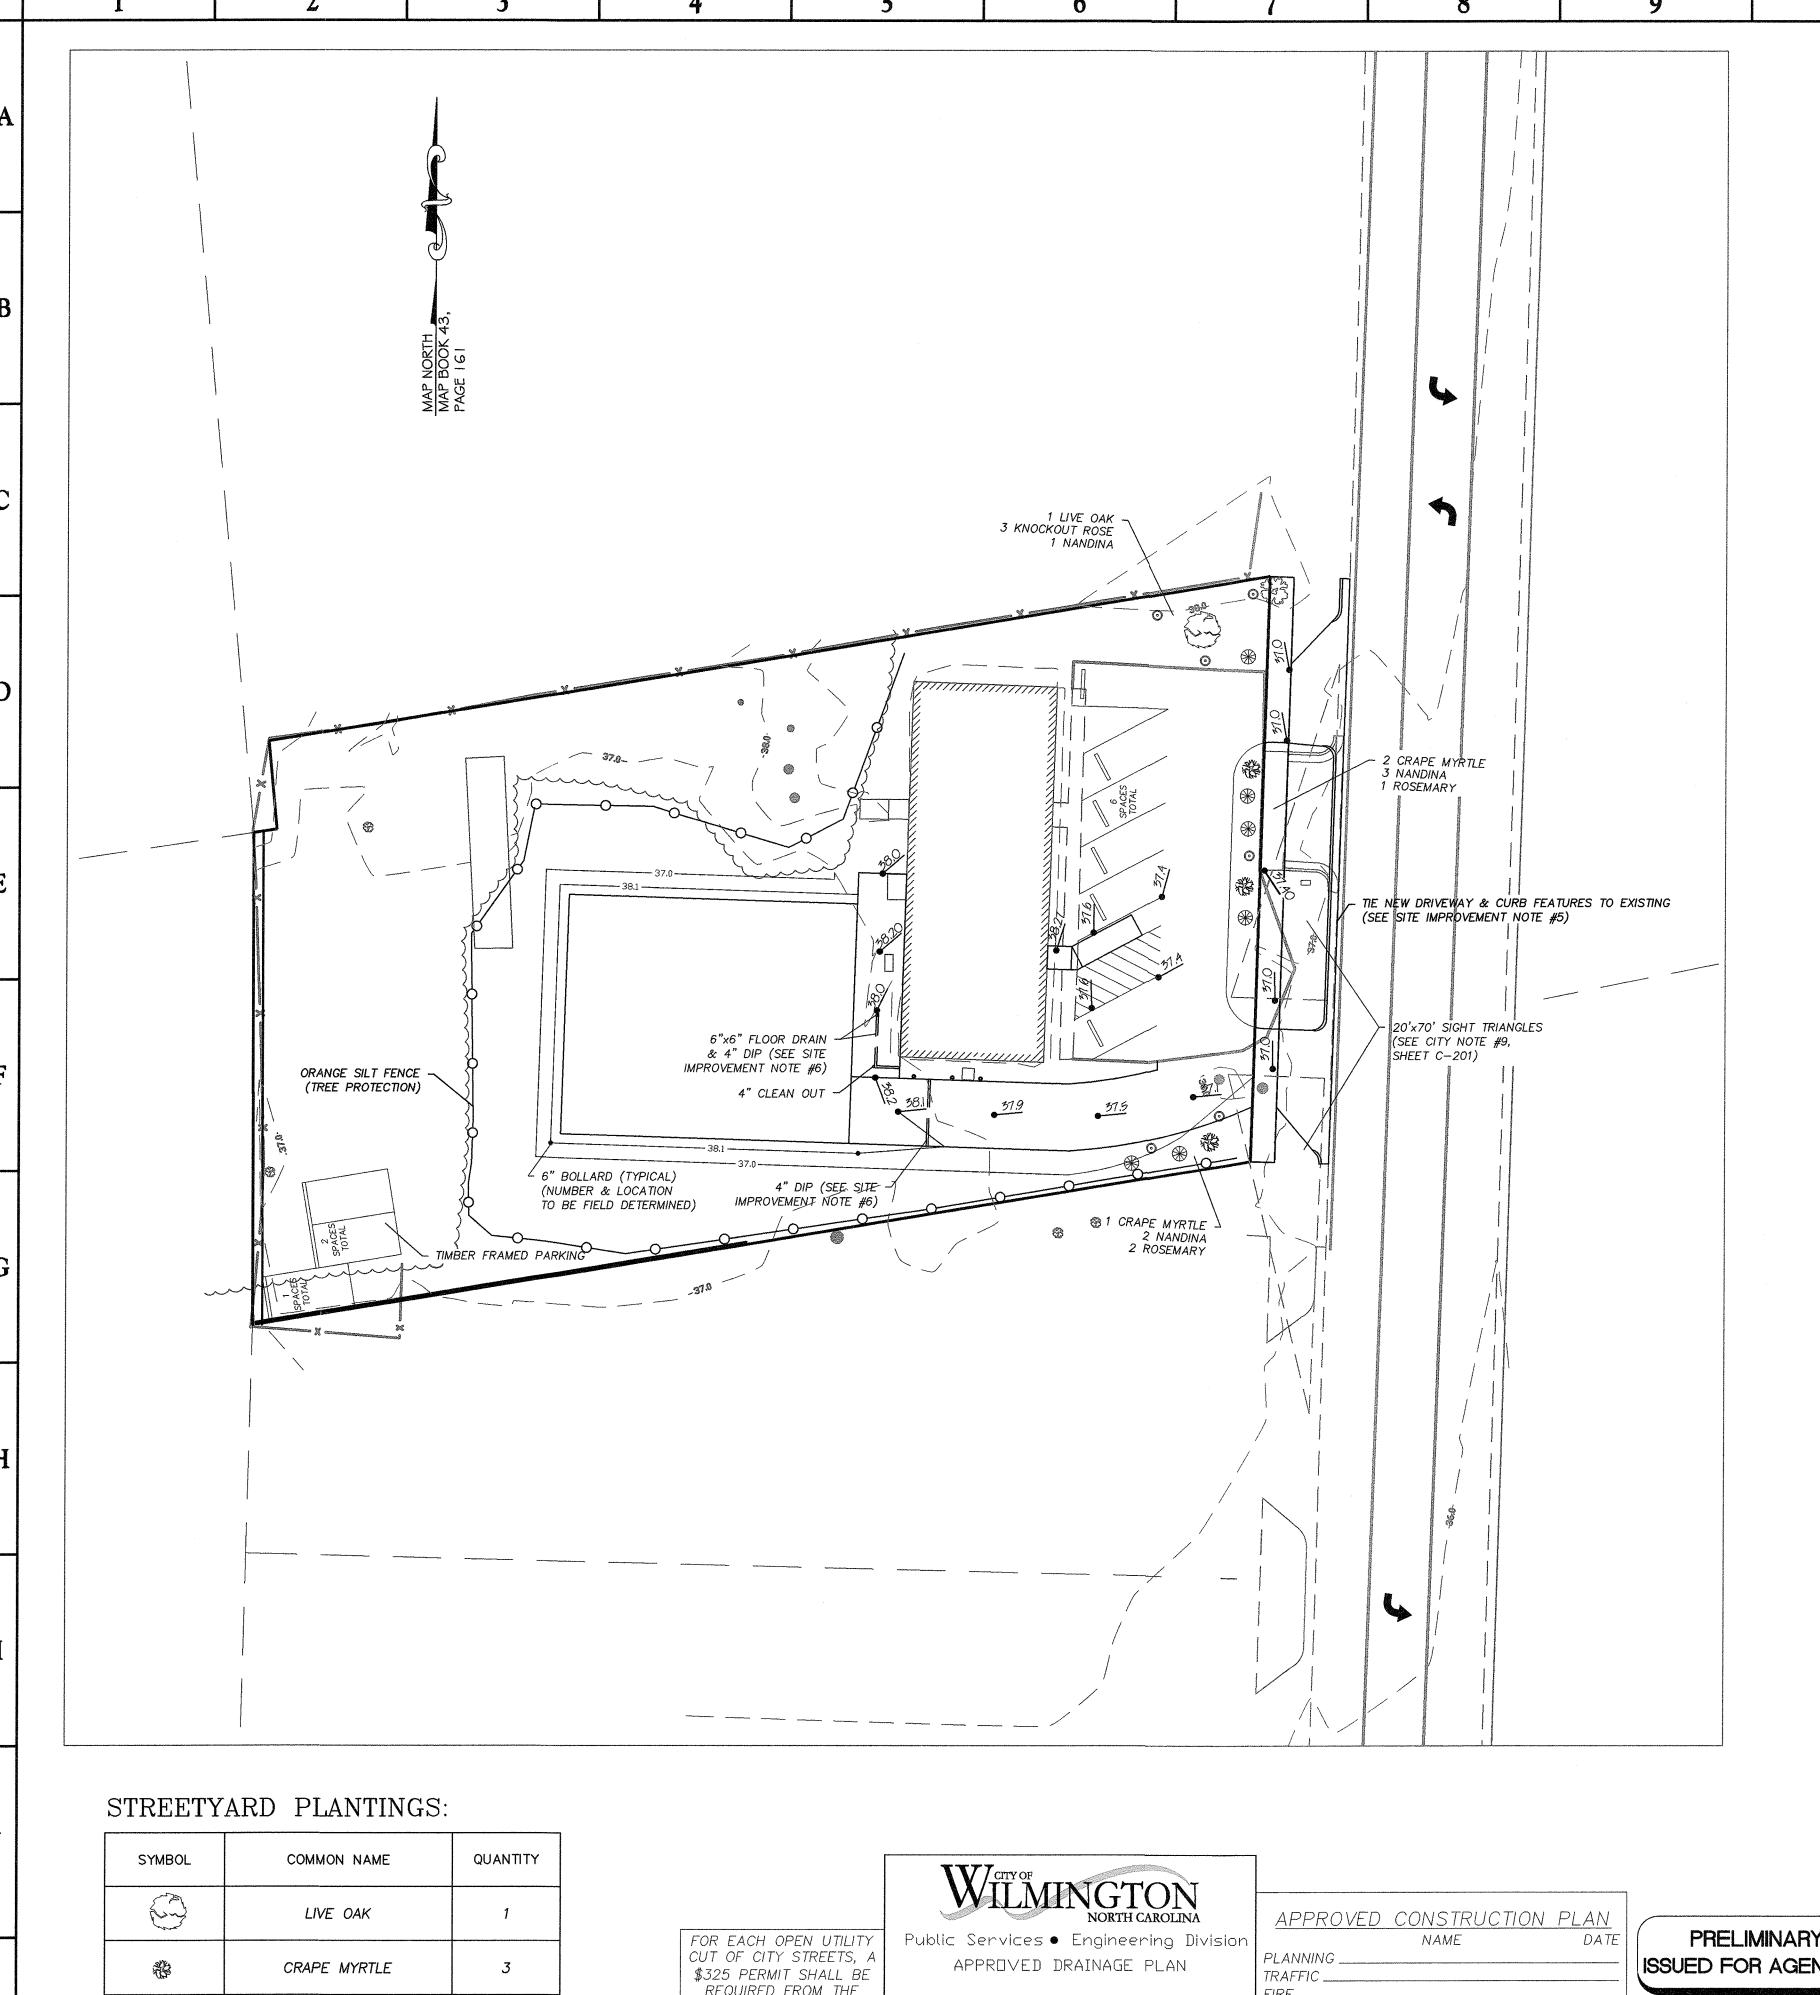- CONTRACTOR SHALL VERIFY ALL EXISTING GRADES AND REPORT ANY DISCREPANCIES TO ENGINEER.
- 2. ALL NEW SPOT ELEVATIONS ARE SHOWN AS FINISHED GRADES. THE CONTRACTOR MUST MAKE ALLOWANCES FOR THICKNESS OF SOD, PAVING SECTIONS, CONCRETE SLABS, RAMPS, ETC. WHERE APPLICABLE.
- ALL NEW SPOT ELEVATIONS ARE TO TOP OF PAVEMENT. AT CURB SECTIONS, TOP OF CURB SHOULD BE IN ACCORDANCE WITH CITY STANDARD DETAILS. FLOW LINE OF CURB SHALL BE SET TO "SPILL" OR "CATCH" CONSISTENT WITH EXISTING ROADWAY AND FLOW LINE OF GUTTER SHALL PROMOTE POSITIVE

14

- 4. CONTRACTOR SHALL ASSURE THE ENTIRE SITE WITHIN THE LIMITS OF CONSTRUCTION IS GRADED TO DRAIN FREELY. ALL UNPAVED AREAS DISTURBED BY CONSTRUCTION, WHETHER INSIDE OR OUTSIDE OF THE LIMIT OF CONSTRUCTED AREA, SHALL BE FINE GRADED TO ESTABLISH POSITIVE DRAINAGE AND SEEDED OR SODDED IN ACCORDANCE WITH OWNER'S
- 5. NO SLOPES SHALL BE GRADED STEEPER THAN 3:1, UNLESS SPECIFICALLY INDICATED OTHERWISE.

#### COMPACTION REQUIREMENTS:

#### 1. BUILDING FOUNDATION,

ALL VEGETATIVE MATTER SHALL BE STRIPPED AND REMOVED WITHIN A PERIMETER 5-FEET WIDER THAN NEW CONSTRUCTION FOOTPRINT (MINIMUM 6-INCHES BELOW EXISTING GRADE).

STRUCTURAL BACKFILL SHALL BE PLACED IN NO GREATER THAN 6" LIFTS AND COMPACTED TO 95% MAX DRY DENSITY (MODIFIED PROCTOR).

CONTRACTOR SHALL PROTECT EXISTING STRUCTURES. NON-VIBRATORY COMPACTION SHALL BE USED AND FILL PLACED IN LESS THAN 4" LIFTS WHEN WORKING WITHIN 10-FEET OF ADJACENT STRUCTURES.

FILL SHALL BE PLACED TO AN ELEVATION THAT FACILITATES EARTHEN FORMING FOR PROPOSED FOUNDATION.

CONTRACTOR SHALL CROSS-REFERENCE STRUCTURAL ENGINEERING PLANS AND MORE RESTRICTIVE / STRINGENT FOUNDATION REQUIREMENTS SHALL

IF UNSUITABLE MATERIAL IS ENCOUNTERED, CONTRACTOR SHALL ENGAGE GEOTECHNICAL PROFESSIONAL AND REPAIR AREA IN ACCORDANCE WITH DOCUMENTED DIRECTION.

2. ASPHALTIC & CONCRETE PAVING, SLABS & WALKS

ALL VEGETATIVE MATTER SHALL BE STRIPPED AND REMOVED WITHIN A PERIMETER 1-FOOT WIDER THAN NEW CONSTRUCTION FOOTPRINT (MINIMUM 6-INCHES BELOW EXISTING GRADE).

EXPOSED SUBGRADE SHALL REMAIN UNDISTURBED AND NOT RUT OR PUMP WHEN SUBJECTED TO EXPECTED LOADS.

WHERE UNSUITABLE SUBGRADE MATERIAL IS ENCOUNTERED, CONTRACTOR SHALL CUT A MINIMUM OF 24-INCHES BELOW SUBGRADE AND REPLACE WITH SUITABLE STRUCTURAL FILL IN 6-INCH LIFTS WITH VIBRATORY COMPACTION TO 100% MAXIMUM DRY DENSITY.

CONTRACTOR SHALL PROTECT EXISTING STRUCTURES. NON-VIBRATORY COMPACTION SHALL BE USED AND FILL PLACED IN LESS THAN 4" LIFTS WHEN WORKING WITHIN 10-FEET OF ADJACENT STRUCTURES.

#### SITE IMPROVEMENT NOTES:

- 1. CONTRACTOR SHALL PROTECT EXISTING FOUNDATION AND STRUCTURES DURING CONSTRUCTION AND PROVIDE SITE ACCESS DURING CONSTRUCTION.
- 2. CONCRETE PLACEMENT SHALL BE IN ACCORDANCE WITH ACI 318-11 UNLESS SPECIFICALLY DIRECTED OTHERWISE BY STRUCTURAL ENGINEER.
- 3. ALL CONCRETE SHALL BE PORTLAND CEMENT CONCRETE WITH MINIMUM 28 DAY COMPRESSIVE STRENGTH OF 4,000 PSI UNLESS SPECIFICALLY STATED OTHERWISE BY STRUCTURAL ENGINEER.
- 4. WHERE NEW CONSTRUCTED SURFACES IMMEDIATELY ABUT EXISTING, CONTRACTOR SHALL SAW CUT A CLEAN, SMOOTH FACE ALONG EXISTING SURFACE PRIOR TO INSTALLING NEW WORK. PROPER EXPANSION JOINT MATERIAL SHALL BE PLACED AT INTERFACE OF NEW AND OLD MATERIAL.
- 5. ALONG DARLINGTON AVENUE, USE OF THE EXISTING EDGE OF PAVEMENT FOR A FORM IS ACCEPTABLE IF THE ROAD IS STRAIGHT AND IN ACCEPTABLE CONDITION. IF THIS EDGE IS NON-UNIFORM OR CRACKING/ SPALLING, CONTRACTOR SHALL SAW-CUT AND REMOVE A MINIMUM OF 1-FOOT OF THE ROADWAY ALONG THE WORK ZONE. ONCE NEW CURB AND DRIVES ARE PLACED, CONTRACTOR SHALL PLACE APPROPRIATE CITY ROAD SECTION IN ACCORDANCE WITH CITY STANDARDS.
- 6. DUCTILE IRON PIPE SHALL BE PLACED BELOW THE SLAB AND BEDDED IN WASHED #57 STONE. PIPE SHALL HAVE WATER TIGHT JOINTS AND BE LAID TO ENSURE POSITIVE DRAINAGE AWAY FROM SLABS AND BUILDINGS. INLETS AND MAINTENANCE FEATURES SHALL BE OF DURABLE METAL, INSTALLED PER MANUFACTURER'S REQUIREMENTS, AND SET FLUSH IN CONCRETE WITH AN INTERIOR FINISH.
- 7. EARTHEN PAD AND SLOPE IMMEDIATELY ADJACENT TO STORAGE ADDITION SHALL BE SODDED TO PROTECT FOUNDATION FROM STORMWATER RUNOFF
- 8. ROOF DRAINS SHALL BE PLACED TO PROTECT BUILDING FOUNDATIONS. PREFERABLY, DOWNSPOUTS SHALL BE DIRECTED TO NEW CONCRETE DRIVEWAY TO FACILITATE DRAINAGE TO DARLINGTON AVENUE.
- 9. ALL AREAS DISTURBED BY CONSTRUCTION AND NOT PERMANENTLY COVERED SHALL BE GRASSED AND MULCHED PER OWNER'S DIRECTION.



POST OFFICE BOX 16110 WILMINGTON, NC 28409 910 - 742 + 3860 PROFESSIONAL FIRM# C-3796

#### 44 DARLINGTON AVE STORAGE ADDITION

WILMINGTON NORTH CAROLINA

PREPARED FOR:

# ZEME, LLC 44 DARLINGTON AVE WILMINGTON, NC 28403

	/ISION		
NO.	DATE	OTS	DESCRIPTION



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#### DRAWING TITLE GRADING, DRAINAGE & PLANTING **PLAN**

DRAWN BY	CHECKED BY
FCL	FCL
DRAWING DATE	DRAWING NUMBER
XX/XX/XX	C-2/1
PROJECT NUMBER	C-241
20-29	
	6 OF 8
NOT ISSUED FOR	CONSTRUCTION


SYMBOL	COMMON NAME	QUANTITY
	LIVE OAK	1
	CRAPE MYRTLE	3
₩	NANDINA	6
<b>©</b>	ROSEMARY OR KNOCKOUT ROSE	6


REQUIRED FROM THE CITY PRIOR TO Date:\_\_\_\_\_ Permit #\_\_\_\_\_ OCCUPANCY AND / OR PROJECT ACCEPTANCE. | Signed: \_\_\_\_\_\_

PRELIMINARY PLAN ISSUED FOR AGENCY REVIEW

SCALE: 1" = 20'

15

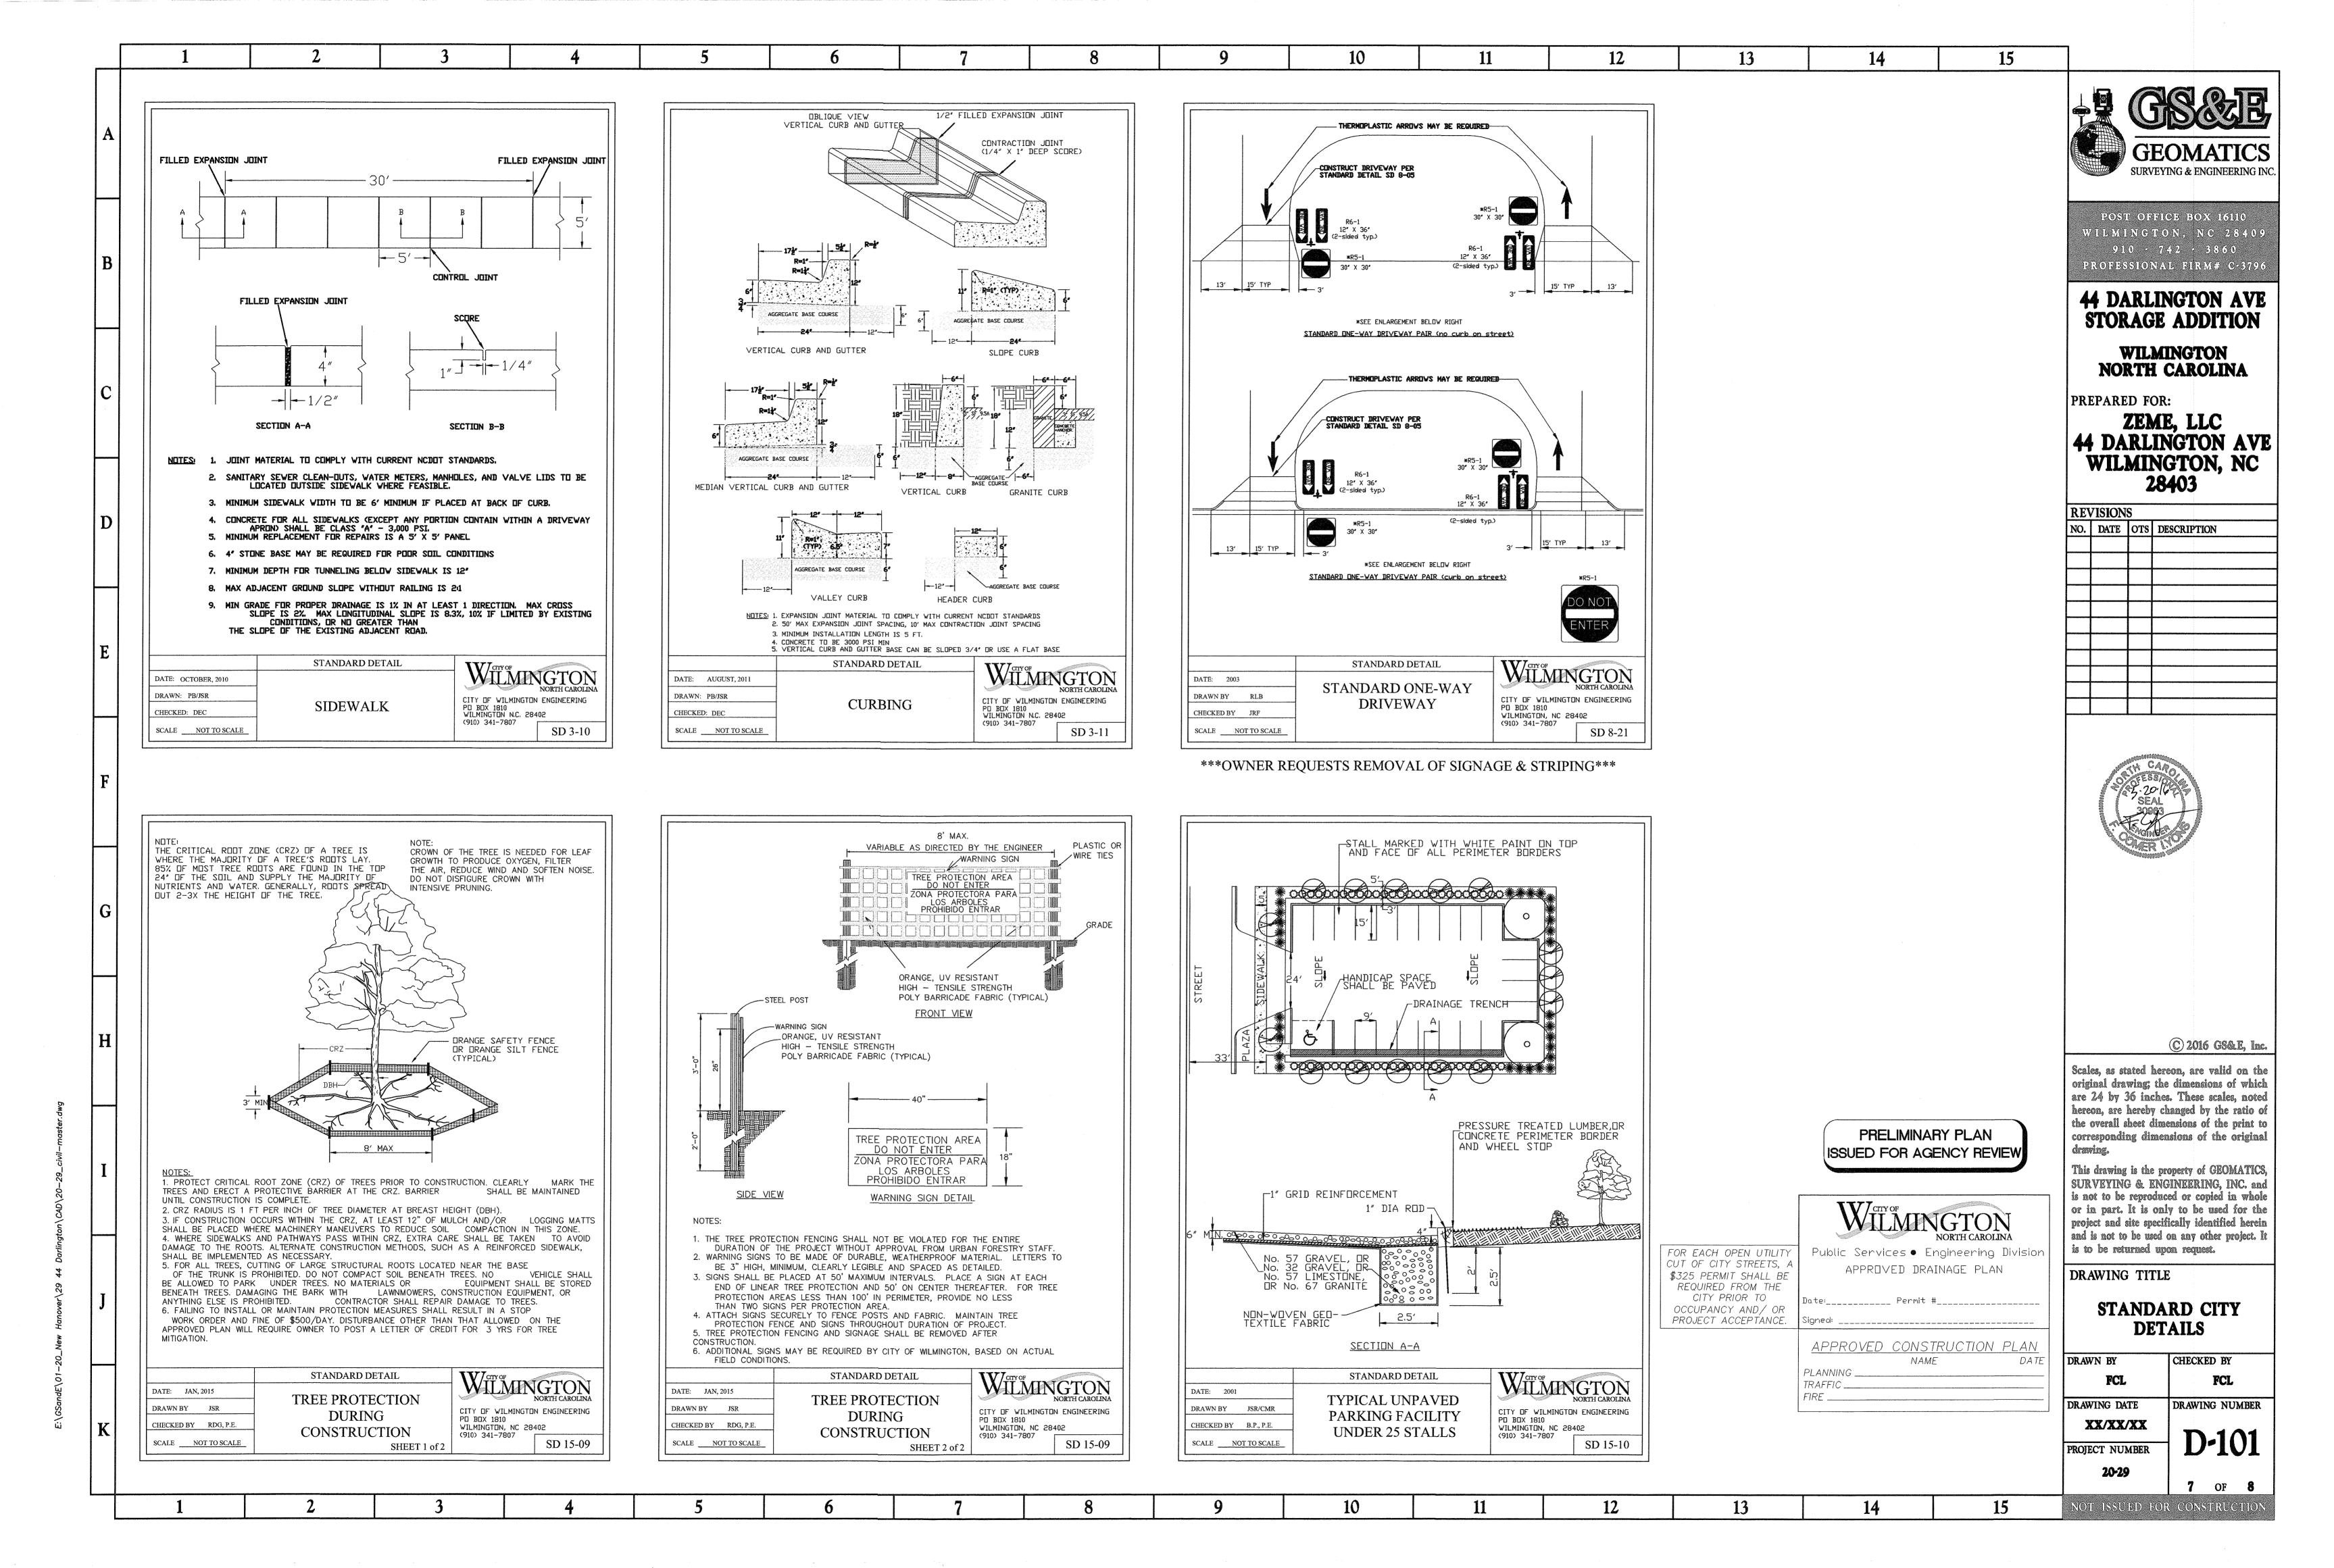

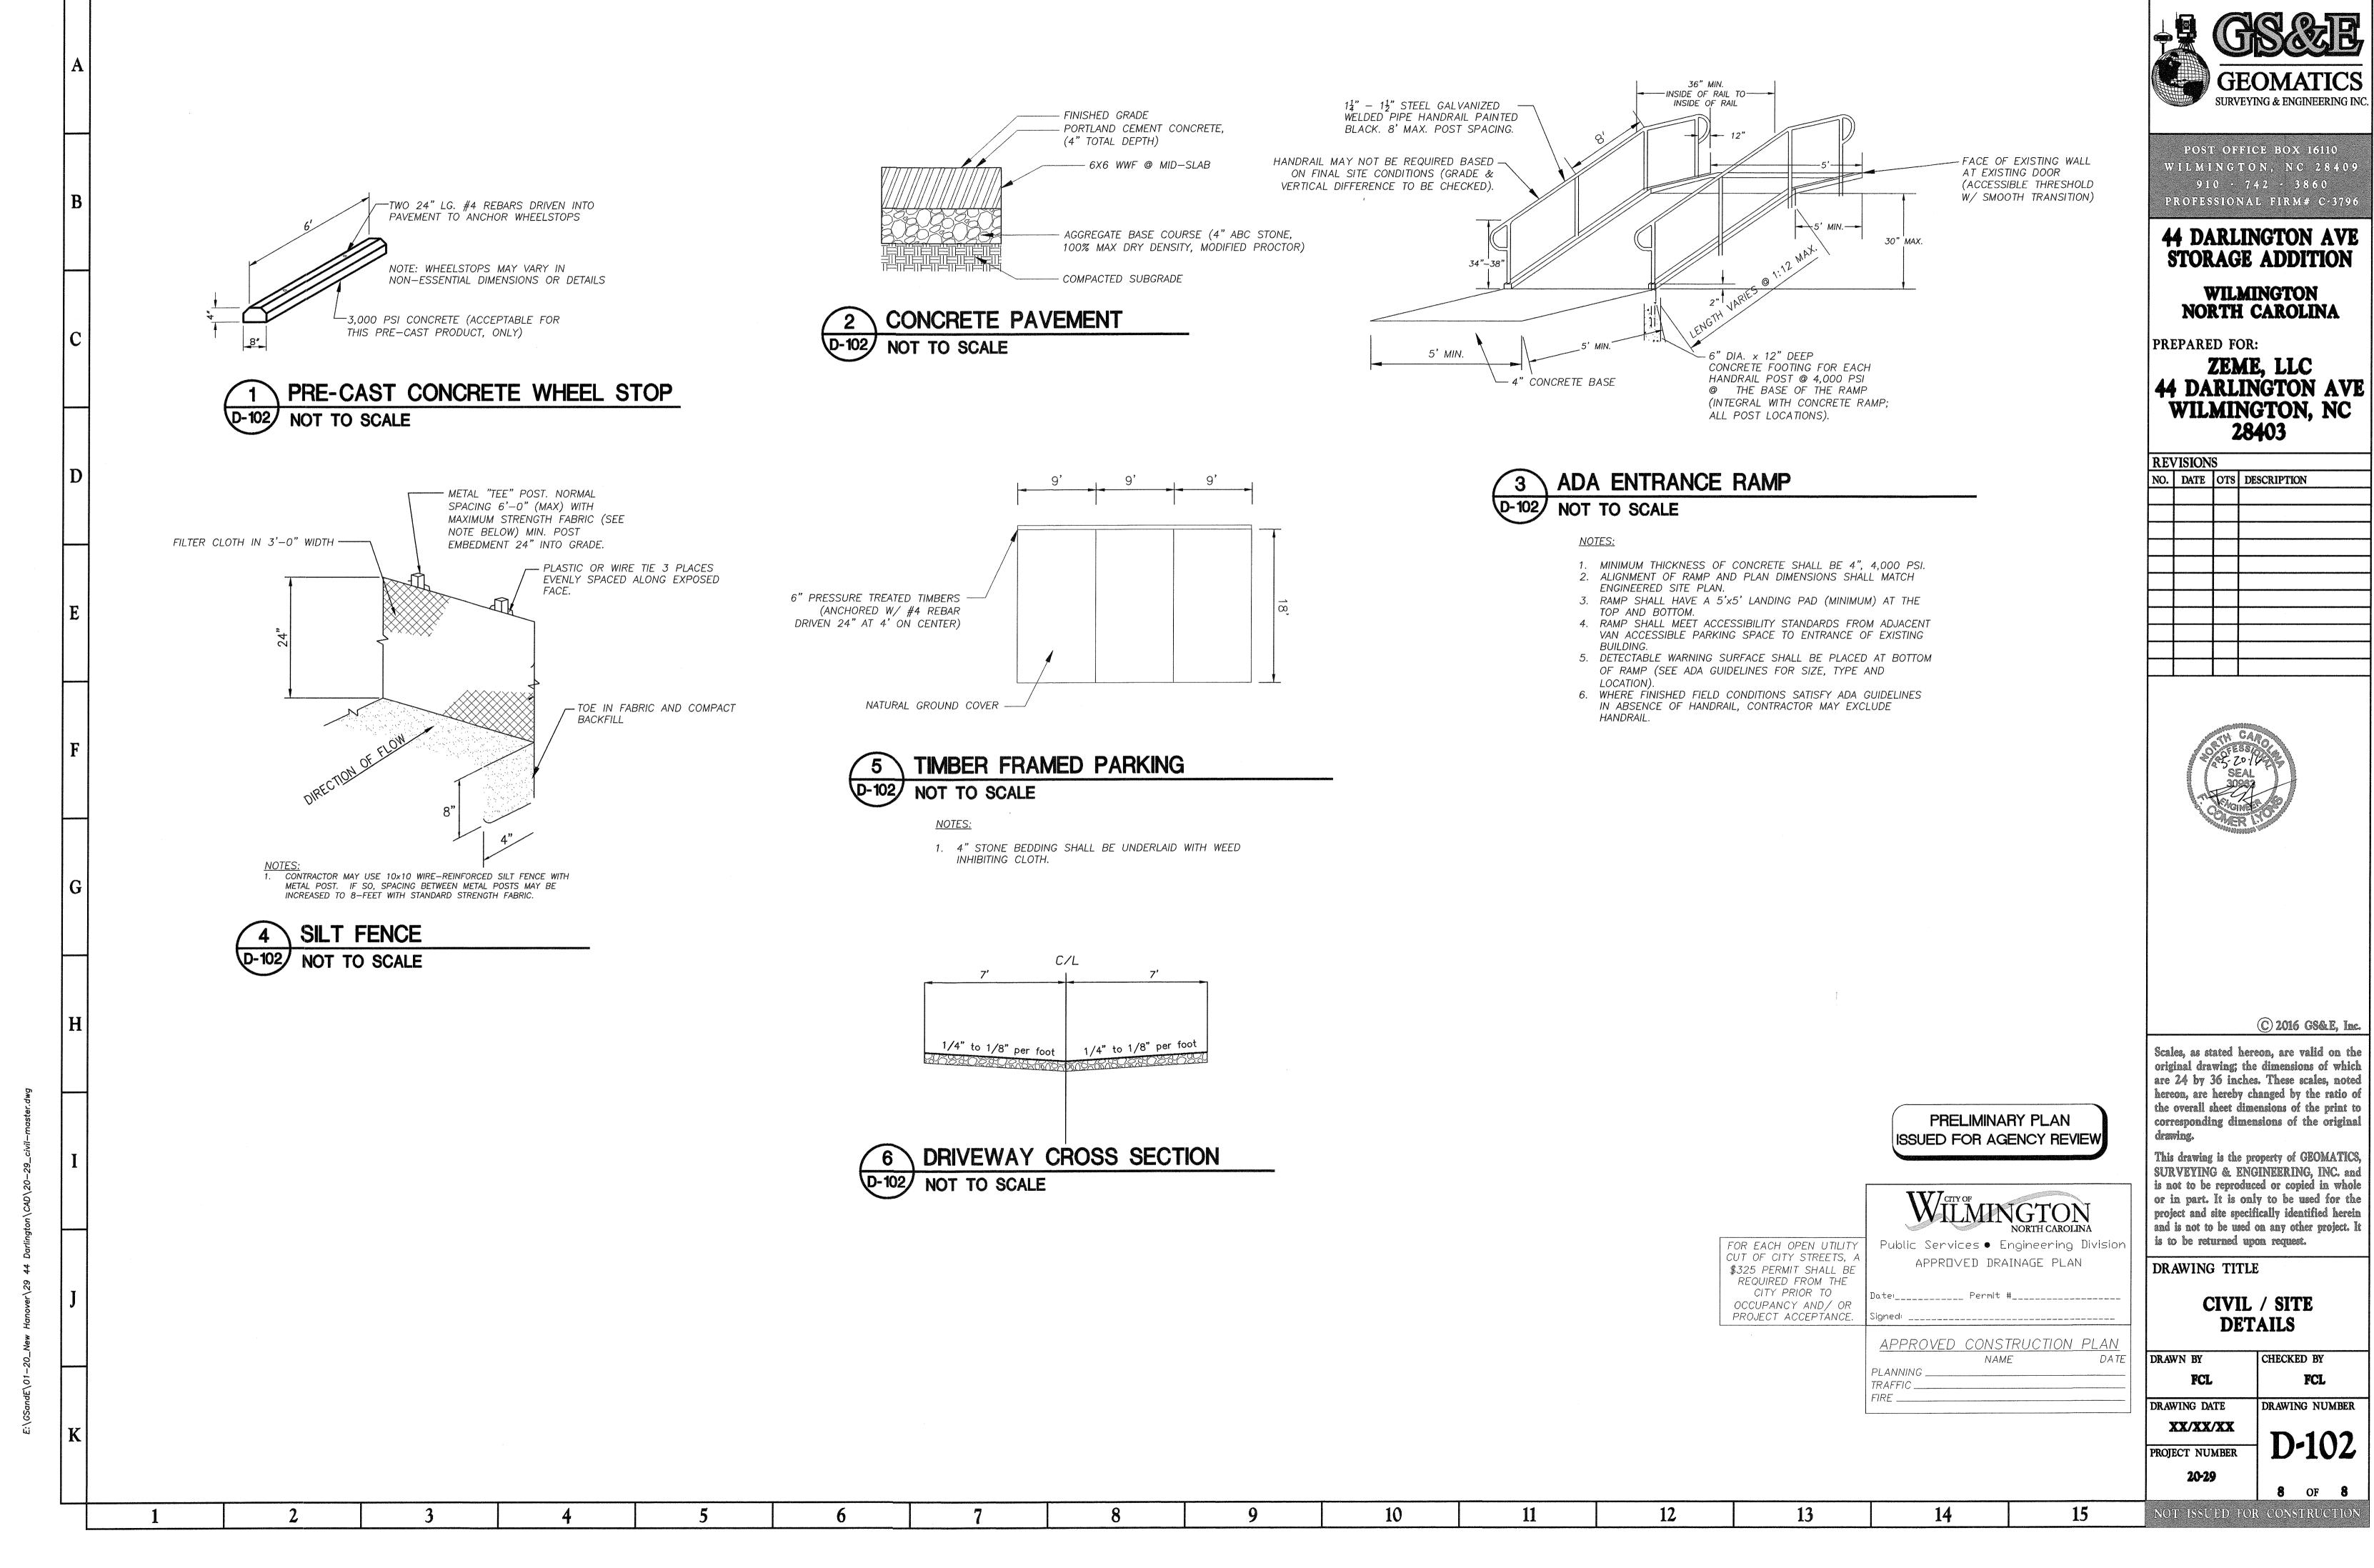

REVISIONS				
NO.	DATE	OTS	DESCRIPTION	